
LOS ALTOS HILLS CALIFORNIA

PROJECT PLANS FOR

SAFE ROUTE TO LOS ALTOS HILLS SCHOOLS RPSTPLE-5324(006), TIP ID - SCL110056

TOWN OF LOS ALTOS HILLS, SANTA CLARA COUNTY, CALIFORNIA

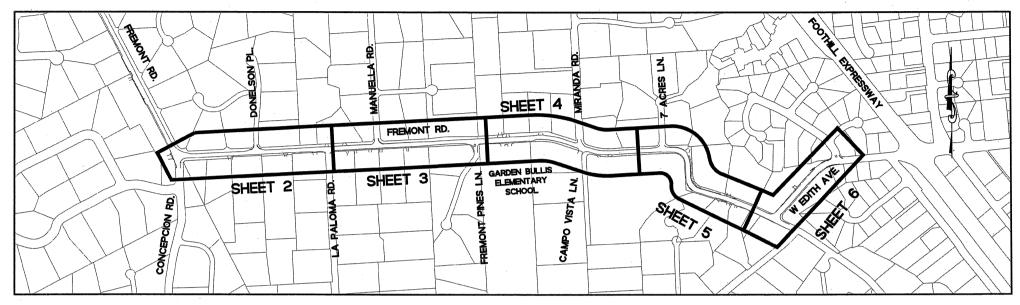

KEY MAP SCALE: 1"=300"

NOTES

- 1. THE CONTRACTOR AGREES THAT IN ACCORDANCE WITH GENERALLY ACCEPTED CONSTRUCTION PRACTICES, THE CONTRACTOR WILL BE REQUIRED TO ASSUME SOLE AND COMPLETE RESPONSIBILITY FOR JOB SITE CONDITIONS DURING THE COURSE OF CONSTRUCTION OF THE PROJECT, INCLUDING SAFETY OF ALL PERSONS AND PROPERTY; THAT THIS REQUIREMENT SHALL BE MADE TO APPLY CONTINUOUSLY AND NOT BE LIMITED TO NORMAL WORKING HOURS: AND THE CONTRACTOR FURTHER AGREES TO DEFEND, INDEMNIFY AND HOLD THE OWNER AND DESIGN PROFESSIONAL HARMLESS FROM ANY AND ALL LIABILITY, REAL OR ALLEGED, IN CONJUNCTION WITH THE PERFORMANCE OF WORK ON THIS PROJECT, EXCEPTING LIABILITY ARISING FROM THE SOLE NEGLIGENCE OF OWNER OR DESIGN PROFESSIONAL.
- 2. LOCATIONS OF EXISTING UNDERGROUND FACILITY AND UTILITIES SHOWN ARE BASED ON FIELD SURVEY AND/OR AVAILABLE UTILITY COMPANY INFORMATION. IT IS THE CONTRACTOR'S RESPONSIBILITY TO VERIFY THE ACTUAL LOCATION OF UTILITY COMPANY INFORMATION PRIOR TO THE COMMENCEMENT OF WORK. THE CONTRACTOR SHALL CONTACT UNDERGROUND SERVICE ALERT (U.S.A.) AT (800)-642-2444 AT LEAST 48 HOURS IN ADVANCE OF ANY EXCAVATING. PHYSICAL VERIFICATION OF UTILITY LOCATION SHALL BE PERFORMED BY POT HOLING OR HAND DIGGING AND CAREFUL SUBSURFACE PROBING IN CONFORMANCE WITH ARTICLE 6 OF THE CAL/OSHA CONSTRUCTION SAFETY ORDERS. ANY DEVIATIONS FROM LOCATIONS SHOWN ON PLANS SHALL BE BROUGHT TO THE ENGINEER'S ATTENTION BEFORE STARTING CONSTRUCTION.
- 3. CONTRACTOR SHALL HAND DIG UTILITY LINES AND BOXES LOCATED WITHIN THE PATHWAY PRIOR TO ANY PATHWAY CONSTRUCTION.
- 4. THESE PLANS ARE FOR USE WITH THE PROJECT CONTRACT DOCUMENTS AND SPECIAL PROVISIONS FOR THE SAFE ROUTES TO LOS ALTOS HILLS SCHOOLS PROJECT.
- 5. THE CONTRACTOR SHALL COORDINATE HIS WORK WITH THAT OF ANY AFFECTED UTILITY
- CONTRACTOR SHALL REPLACE OR REPAIR, AT CONTRACTOR'S EXPENSE, ALL DAMAGED, REMOVED OR OTHERWISE DISTURBED WALLS, FENCES, SERVICES, UTILITIES, IMPROVEMENTS OR FEATURES OF WHATEVER NATURE, TO THEIR ORIGINAL CONDITION, WHETHER ON THE PLANS OR NOT; PROVIDED SUCH REPAIR OR REPLACEMENT IS CAUSED BY CONTRACT WORK OPERATIONS.
- 7. LIMITS OF PATHWAY ARE SAME AS LIMITS OF WORK UNLESS NOTED OTHERWISE IN PLANS OR SPECIAL PROVISIONS.
- 8. THE CONTRACTOR SHALL NOTIFY THE PROPERTY OWNERS OR OCCUPANTS OF AFFECTED PROPERTIES WITH A WRITTEN NOTICE ONE WEEK PRIOR AND WITH A WRITTEN REMINDER ONE DAY PRIOR TO THE BEGINNING OF CONSTRUCTION, AND NO SEPERATE PAYMENT SHALL BE ALLOWED
- 9. THE CONTRACTOR SHALL COORDINATE WITH LOS ALTOS GARBAGE COMPANY FOR CURB SIDE
- 10. THE CONTRACTOR SHALL PREPARE AND SUBMIT A SAFETY PLAN, TRAFFIC CONTROL PLAN, AND A STORM WATER POLLUTION PREVENTION PLAN, FOR REVIEW AND APPROVAL BY THE ENGINEER PRIOR TO COMMENCEMENT OF CONSTRUCTION ACTIVITIES.

ABBREVIATIONS AGGREGATE BASE

ASPHALT CONCRETE AVERAGE BEGINNING OF CURVE BACKFLOW PREVENTER BLOW OFF VALVE CURB AND GUTTER CATCH BASIN CONTINUED CONCRETE DECOMPOSED GRANITE DRAIN INLET DRIVEWAY EL (E)/EX FI FCTRICAL EXISTING EACH END OF CURVE EDGE OF PAVEMENT FIRE HYDRANT GRADE BREAK GAS VALVE HIGH DENSITY POLYETHYLENE MAXIMIIM MAIL BOX METAL BEAM GUARD RAIL MANHOLF MINIMIM MONUMENT NEW NOT TO SCALE ON CENTER POINT OF COMPOUND CURVE PORTLAND CEMENT CONCRETE POWER POLE POINT OF REVERSE CURVE PRESSURE TREATED RC/R.C. RELATIVE COMPACTION REINFORCED CONCRETE PIPE

STORM DRAIN

TELEPHONE

STATION SOLIARE YARD

SQUARE FEET

ABBREVIATIONS CONT.

TOP OF CURVE TOP OF DIKE TYPICAL UNDERGROUND SERVICE ALERT WATER METER WVLT WATER VAULT

LEGEND	
EXISTING PROPOSED	
DI B	STORM DRAIN INLET
0	STORM DRAIN MANHOLE
S	SANITARY SEWER MANHOLE
₩	WATER VALVE
Ħ	FIRE HYDRANT
MON	MONUMENT
PP -Ö-	POWER POLE/UTILITY POLE
	MAIL BOX
₩M ⊞	WATER METER
×	LIGHT
0	SIGN
•	BENCHMARK
Œ	ELECTRICAL BOX
#	DETAIL NO.
	DECOMPOSED GRANITE
	PERVIOUS CONCRETE

OVERHEAD LINE

-OH----OH-

CALL TWO WORKING DAYS BEFORE YOU DIG IN CALIFORNIA, NEVADA AND HAWAII 1-800-227-2600 UNDERGROUND SERVICE ALERT



SHEET NUMBERS AND TITLES

- TITLE SHEET
- IMPROVEMENT PLAN, STA 60+00 TO 70+00
- IMPROVEMENT PLAN. STA 70+00 TO 80+00
- IMPROVEMENT PLAN, STA 80+00 TO 90+00
- IMPROVEMENT PLAN, STA 90+00 TO 99+50 IMPROVEMENT PLAN, STA 99+50 TO 105+50
- CONSTRUCTION DETAILS
- CONSTRUCTION DETAILS
- CONSTRUCTION DETAILS
- CONSTRUCTION DETAILS
- PLANTING AND IRRIGATION, STA 60+00 TO 70+00
- 12 PLANTING AND IRRIGATION, STA 70+00 TO 80+00
- PLANTING AND IRRIGATION, STA 80+00 TO 90+00
- 14 PLANTING AND IRRIGATION STA 90+00 TO 99+50
- L5. PLANTING AND IRRIGATION, STA 99+50 TO 105+50
- 16. PLANTING AND IRRIGATION DETAILS

TOWN OF LOS ALTOS HILLS



PLANS PREPARED UNDER MY SUPERVISION

BRan DATE: 7/10/12 R.L.A. 2223, EXPIRES 09/30/12



EDWARD T. SLINTAK DATE: 7/11/12 R.C.E. 39925, EXPIRES 12/31/13





TITLE SHEET

SAFE ROUTE TO LOS ALTOS HILLS SCHOOLS


LOS ALTOS HILLS, CALIFORNIA


	REVISIONS		
NO.	DATE	DESCRIPTION	
		-	

ENGTH OF BAR BELOW IS 1-INCH.
BAR MEASURES LESS THAN F BAR MEASURES LESS THAIN
I-INCH, THIS SHEET WAS PLOTTED
AT A REDUCED SCALE, WHICH
MAY REQUIRE ADJUSTMENT OF SCALE(S) SHOWN ON DRAWING.

PROJECT	DATE
11-321	JUNE 11, 2012
DRAWN BY	CHECKED BY
DD/JG	ES/AC

SHEET NO.

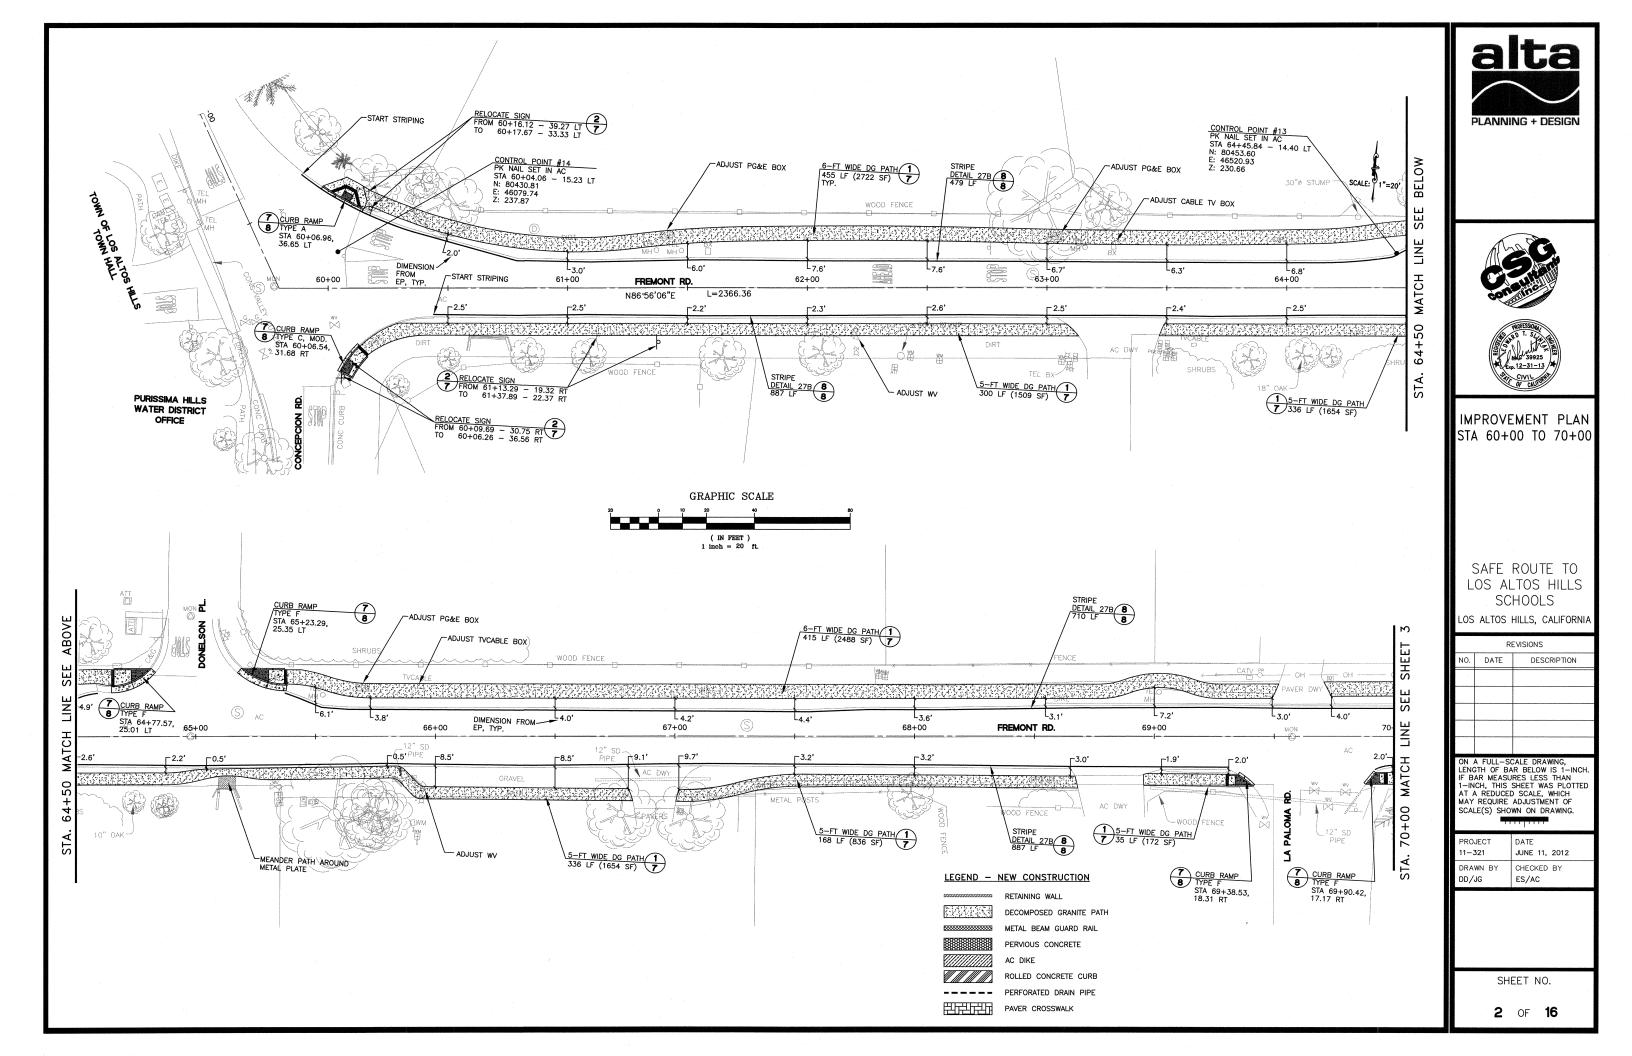

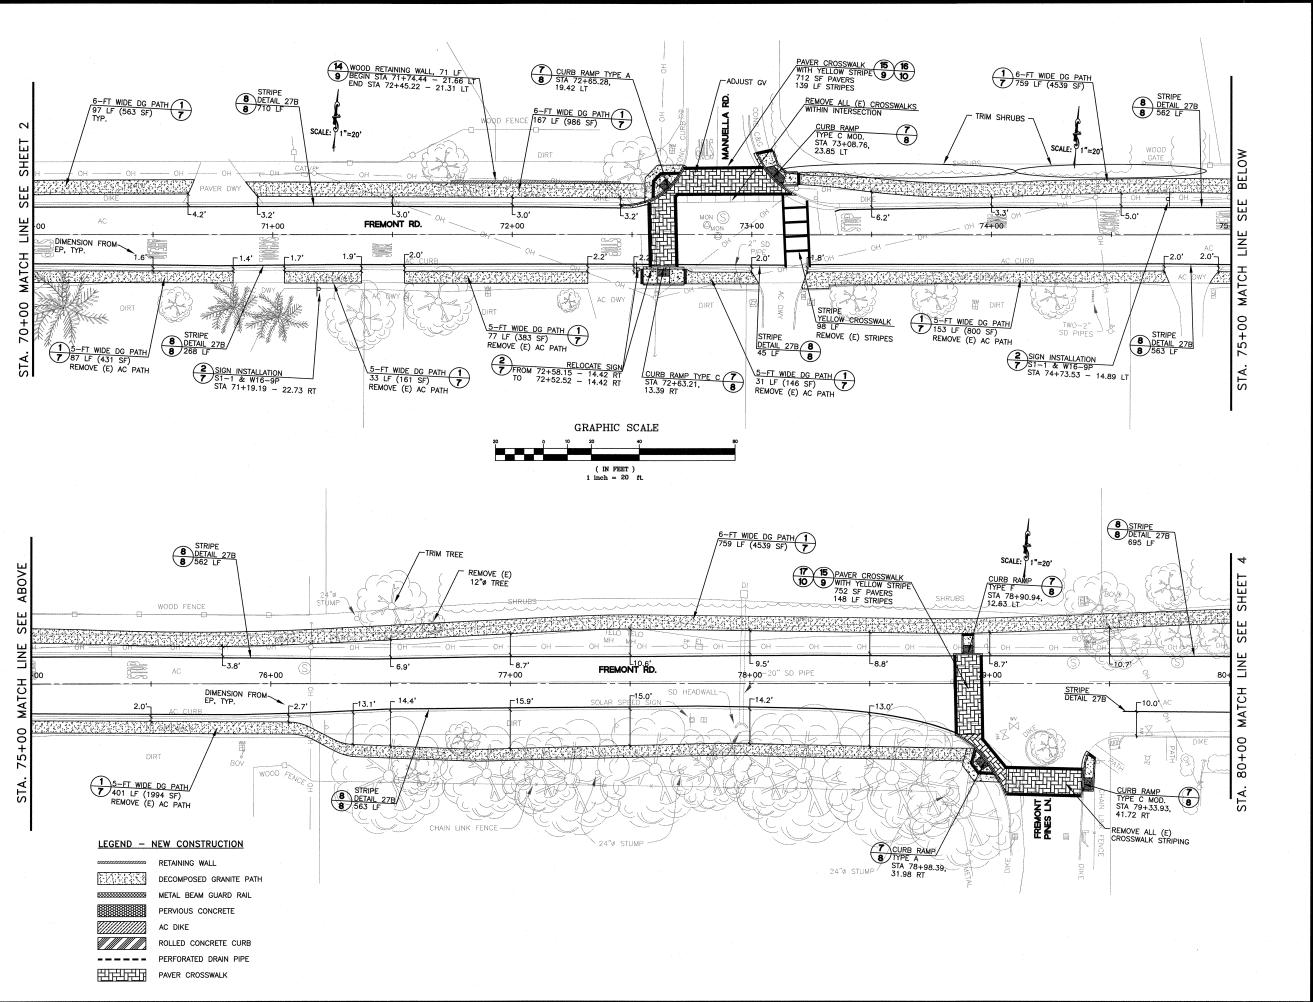







IMPROVEMENT PLAN STA 70+00 TO 80+00

SAFE ROUTE TO LOS ALTOS HILLS SCHOOLS

LOS ALTOS HILLS, CALIFORNIA


I	REVISIONS		
	NO.	DATE	DESCRIPTION
I			
I			
I			

ON A FULL—SCALE DRAWING, LENGTH OF BAR BELOW IS 1—INCH. IF BAR MEASURES LESS THAN 1—INCH, THIS SHEET WAS PLOTTED AT A REDUCED SCALE, WHICH MAY REQUIRE ADJUSTMENT OF SCALE(S) SHOWN ON DRAWING.

سياسين

Н	PROJECT	DATE	
ŀ	11-321	JUNE 11, 2012	
	DRAWN BY	CHECKED BY	
	DD/JG	ES/AC	

SHEET NO.

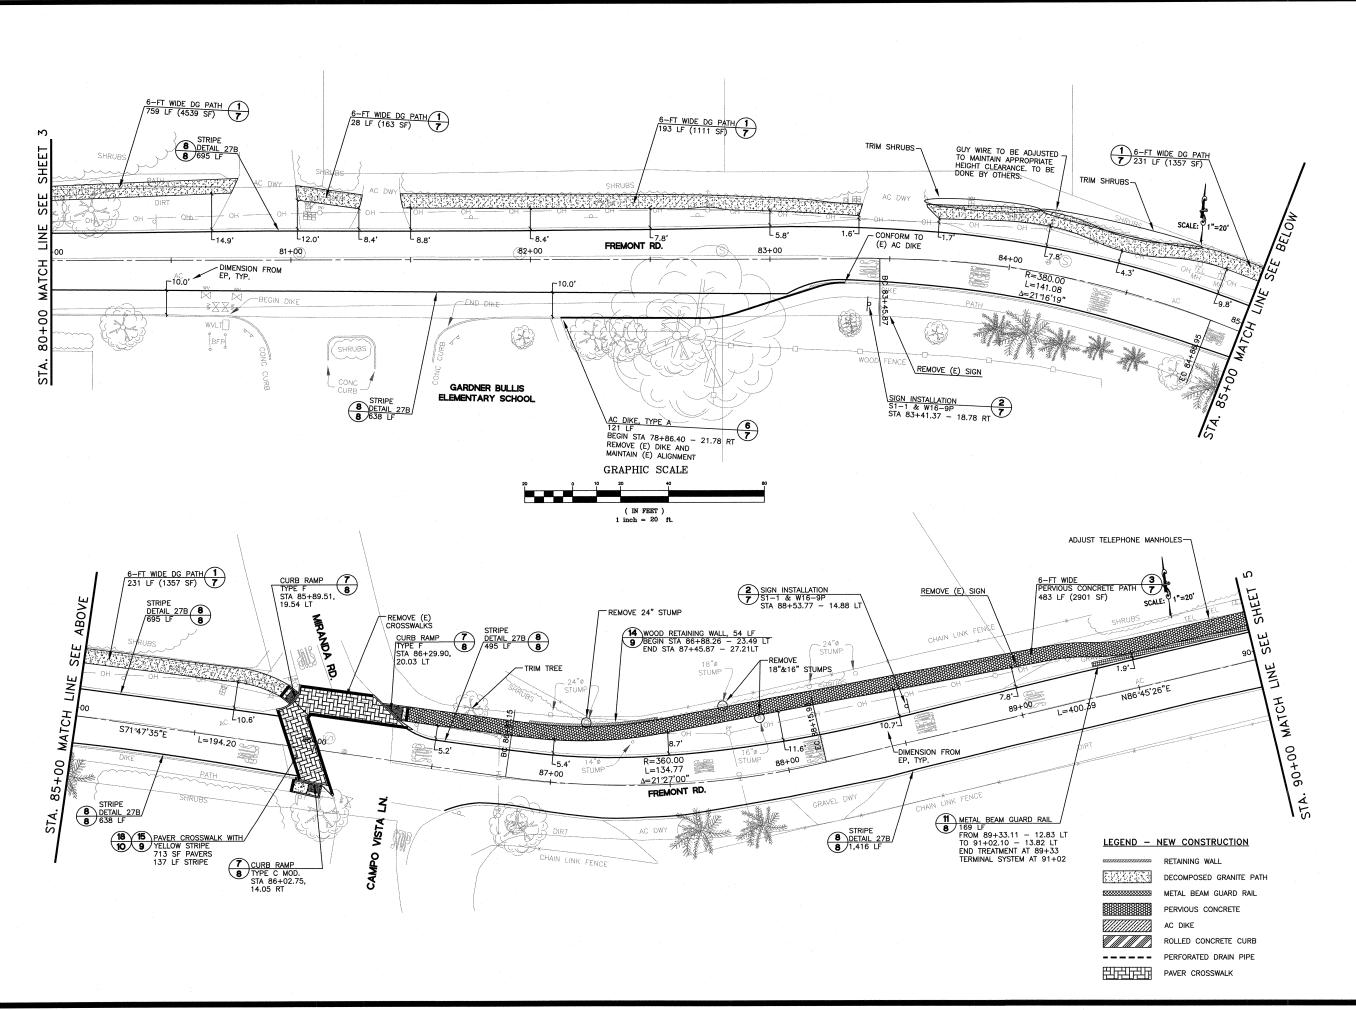







IMPROVEMENT PLAN STA 80+00 TO 90+00

SAFE ROUTE TO LOS ALTOS HILLS SCHOOLS

LOS ALTOS HILLS, CALIFORNIA


	REVISIONS		
NO.	DATE	DESCRIPTION	
		-	
	-		
	ON A FULL-SCALE DRAWING,		

ON A FULL—SCALE DRAWING, LENGTH OF BAR BELOW IS 1—INCH. IF BAR MEASURES LESS THAN 1—INCH, THIS SHEET WAS PLOTTED AT A REDUCED SCALE, WHICH MAY REQUIRE ADJUSTMENT OF SCALE(S) SHOWN ON DRAWING.

7777777

PROJECT 11-321	DATE JUNE 11, 2012
DRAWN BY DD/JG	CHECKED BY ES/AC

SHEET NO.

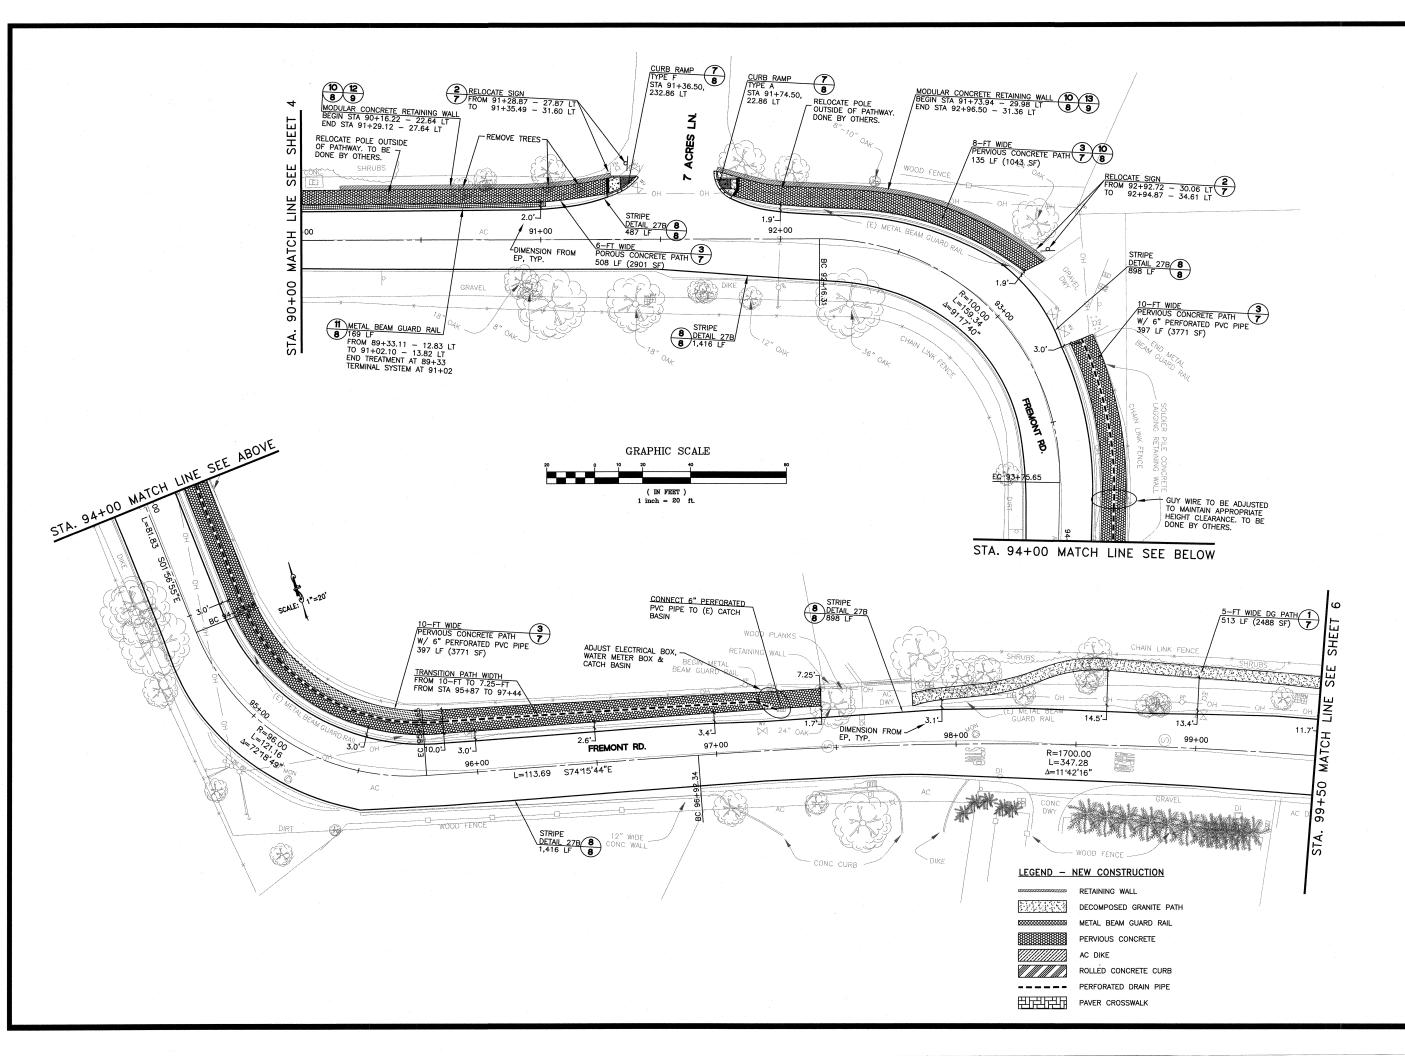







IMPROVEMENT PLAN STA 90+00 TO 99+50

SAFE ROUTE TO LOS ALTOS HILLS SCHOOLS

LOS ALTOS HILLS, CALIFORNIA


		REVISIONS			
ı		NO.	DATE	DESCRIPTION	
				-	
	H			-	
	ŀ				
	H				
ı	ı	ON .	A FULL-SO	CALE DRAWING.	

ON A FULL-SCALE DRAWING, LENGTH OF BAR BELOW IS 1-INCH. IF BAR MEASURES LESS THAN 1-INCH, THIS SHEET WAS PLOTTED AT A REDUCED SCALE, WHICH MAY REQUIRE ADJUSTMENT OF SCALE(S) SHOWN ON DRAWING.

DATE

ŀ	PROJECT	DATE
	11-321	JUNE 11, 2012
	DRAWN BY	CHECKED BY
Г	DD/JG	ES/AC

SHEET NO.

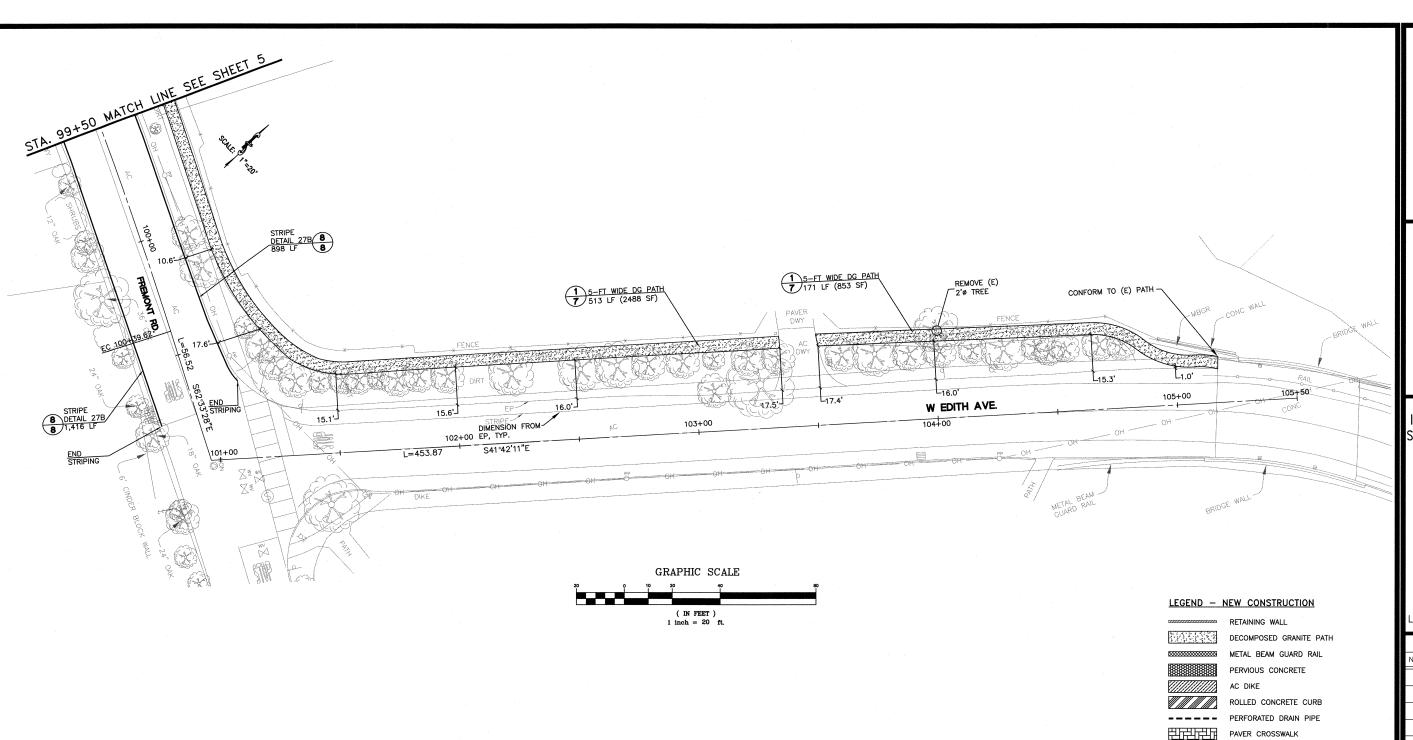







IMPROVEMENT PLAN STA 99+50 TO 105+50

SAFE ROUTE TO LOS ALTOS HILLS SCHOOLS

LOS ALTOS HILLS, CALIFORNIA

ı	ŀ			
		REVISIONS		
į		NO.	DATE	DESCRIPTION
1				-


ON A FULL—SCALE DRAWING, LENGTH OF BAR BELOW IS 1—INCH. IF BAR MEASURES LESS THAN 1—INCH, THIS SHEET WAS PLOTTED AT A REDUCED SCALE, WHICH MAY REQUIRE ADJUSTMENT OF SCALE(S) SHOWN ON DRAWING.


DJECT DATE


321 JUNE 11, 2012


DRAWN BY CHECKED BY DD/JG ES/AC

SHEET NO.

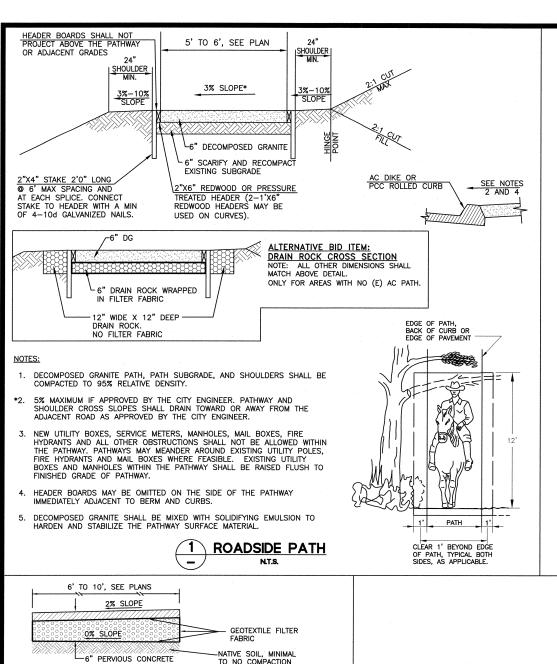

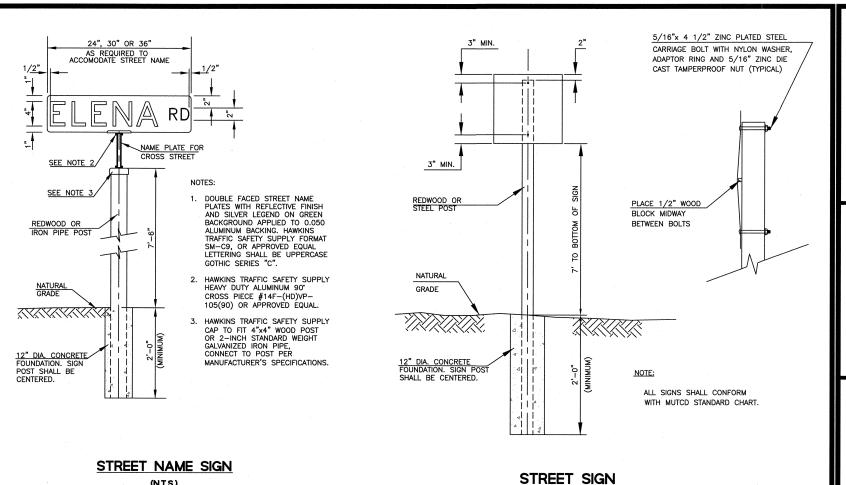

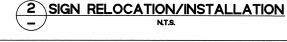

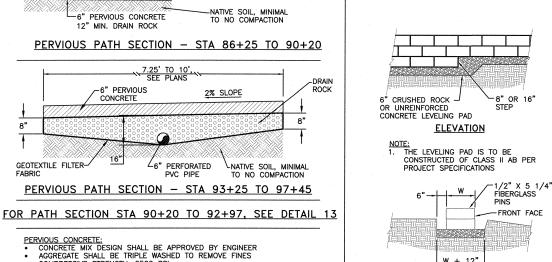

- COMPRESSIVE STRENGTH: 2500 PSI


DRAIN ROCK:

• UNIFORMLY GRADED CLEAN CRUSHED ROCK - 1" SIZE INSTALLED IN SINGLE LIFT, COMPACTED WITH A SINGLE PASS OF 8-TON ROLLER

- FILTER FABRIC:


 NON-WOVEN GEOTEXTILE COMPOSED OF POLYPROPYLENE FIBERS. MIRAFI 160N OR APPROVED EQUAL.

 OVERLAP ADJACENT STRIPS OF FILTER FABRIC AT LEAST 16". FABRIC
- TO RUN DOWN EACH SIDE OF THE DRAIN ROCK. 3 PERVIOUS CONCRETE PATH N.T.S.

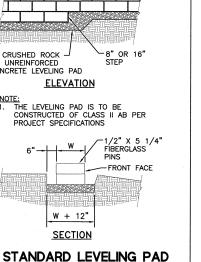

W + 12"

SECTION

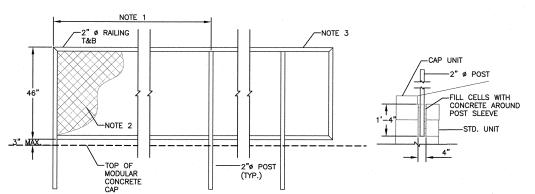


NOTE:

1. CENTER TO CENTER SPACING OF POSTS TO BE 7'-6" TYPICAL OR EVEN MULTIPLES OF 1'-6".

(N.T.S.)

- 3. CANTILEVER SECTION USED TO CLOSE GAPS BETWEEN RAILING SECTIONS, 4'-0" MAX. LENGTH. GAP BETWEEN RAILING SECTION TO BE LESS THAN 4". AT CHANGES IN DIRECTION OF RAIL, ANGLE
- BEVEL OUTSIDE JOINTS AS SHOWN. WELD ALL JOINTS AND GRIND SMOOTH.
- 2. BLACK VINYL COATED 42" HIGH CHAIN LINK FENCE 5. RAILING SECTIONS TO BE SHOP FABRICATED AND GALVANIZED.



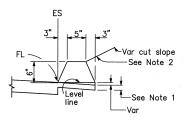

TYPE A

NOTES:

- 1. For AC shoulders only, extend top layer of AC placed on the shoulder under dike with no joint at the ES.
- 2. Fill and compact with excavated material to top of dike.

DIKE QUANTITIES

•		
	CUBIC YARDS	
TYPE	PER LINEAR FOOT	
Α	0.0135	
D	0.0293	

Quantities based

AC DIKE, CALTRANS TYPE A N.T.S.





CONSTRUCTION DETAILS

SAFE ROUTE TO LOS ALTOS HILLS **SCHOOLS**

OS ALTOS HILLS, CALIFORNIA


I		REVISIONS		
I	NO.	DATE	DESCRIPTION	
I				
ı				
I				
I				
I		,		


BAR MEASURES LESS THAN INCH. THIS SHEET WAS PLOTTED AT A REDUCED SCALE, WHICH MAY REQUIRE ADJUSTMENT OF SCALE(S) SHOWN ON DRAWING.

PROJECT	DATE
11-321	JUNE 11, 2012
DRAWN BY	CHECKED BY
DD/JG	ES/AC


on 5% cross slope.

SHEET NO.

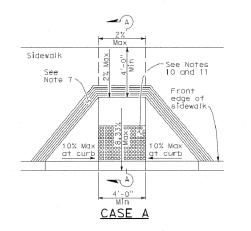


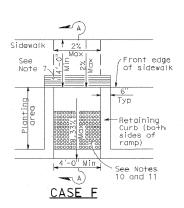

RAISED TRUNCATED DOME

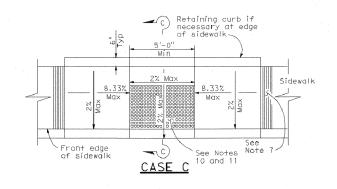



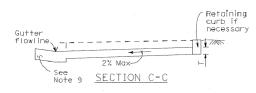

BACK OF CURB OR DIKE

OR DIKE

DETAIL 27B

LINES

- WOOD BLOCK

11 METAL BEAM GUARD RAIL

Edge of pavement

4" White Stripe

Direction of Travel

STRIPING DETAIL 27B

SEE MAY 2006 CALTRANS STANDARD PLANS A77A1 FOR MBGR INSTALLATION DETAILS

AND DIMENSIONS. SEE A77H1 FOR END ANCHOR

ASSEMBLY AND A77L2 FOR TERMINAL SYSTEM.

- SEE PLANS

FOR SURFACE

WOOD POST, SEE CALTRANS STANDARD

PLANS A77A1 FOR DEPTHS.







CONSTRUCTION DETAILS

SAFE ROUTE TO LOS ALTOS HILLS SCHOOLS

LOS ALTOS HILLS, CALIFORNIA

DATE

REVISIONS

ı			
	LENG	GTH OF BA	CALE DRAWING, IR BELOW IS 1-INCH RES LESS THAN

AT A REDUCED SCALE, WHICH MAY REQUIRE ADJUSTMENT OF SCALE(S) SHOWN ON DRAWING.

PROJECT	DATE
11-321	JUNE 11, 2012
DRAWN BY	CHECKED BY


DD/JG ES/AC

SHEET NO.

8 OF 16



- AS SITE CONDITIONS DICTATE, CASE A CURB RAMPS MAY BE USED FOR CORNER INSTALLATIONS SIMILAR TO THOSE SHOWN IN DETAIL B.
- 3. WHEN RAMP IS LOCATED IN CENTER OF CURB RETUN, CROSSWALK CONFIGURATION MUST BE SIMILAR TO THAT SHOWN IN DETAIL B.
- 5. IF LOCATED ON A CURVE, THE SIDES OF THE RAMP NEED NOT BE PARRALLEL, BUT THE MINIMUM WIDTH OF THE RAMP SHALL BE 4'-0".
- 6. SIDE SLOPE OF RAMP FLARES VARY UNIFORMLY FROM A MAXIMIM OF 10% AT CURB TO CONFORM WITH LONGITUDINAL SIDEWALK SLOPE ADJACENT TO TOP OF THE RAMP, EXCEPT IN CASE C AND CASE F.
- 7. THE CURB RAMP SHALL BE OUTLINED, AS SHOWN, WITH 1'-0" WIDE BORDER WITH 1" GROOVES APPROXIMATELY 1" ON CENTER. SEE GROOVING DETAIL.
- 8. TRANSITIONS FROM RAMPS AND LANDING TO WALKS, GUTTERS OR STREETS SHALL BE FLUSH AND
- 9. MAXIMUM SLOPES OF ADJOINING GUTTERS, THE ROAD SURFACE IMMEDIATELY ADJACENT TO THE CURB RAMP OR ACCESSIBLE ROUTE SHALL NOT EXCEED 5% WITHIN 4'-0" OF THE TOP AND BOTTOM OF THE CURB RAMP.
- 10. CURB RAMPS SHALL HAVE A DETECTABLE WARNING SURFACE THAT EXTENDS THE FULL WIDTH AND 3'-0" DEPTH OF THE RAMP. DETECTABLE WARNING SURFACES SHALL CONFORM TO THE DETAILS ON THE PLAN AND THE REQUIREMENTS IN THE SPECIAL PROVISIONS OF THE STATE OF CALIFORNIA STANDARD SPECIFICATIONS.
- 11. THE EDGE OF THE DETECTABLE WARNING SURFACE NEAREST THE STREET SHALL BE BETWEEN 6" AND 8" FROM THE GUTTER FLOWLINE.
- 12. SIDEWALK AND RAMP THICKNESS, "T", SHALL BE 31 MINIMUM.
- 13. UTILITY PULL BOXES, MANHOLES, VAULTS AND ALL OTHER UTILITY FACILITIES WITHIN THE BOUNDARIES OF THE CURB RAMP WILL BE RELOCATED OR ADJUSTED TO GRADE BY THE OWNER PRIOR TO, OR IN CONJUCTION WITH, CURB RAMP CONSTRUCTION.

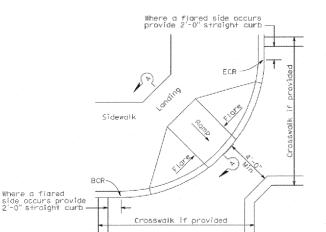

TYPICAL ONE-RAMP CORNER INSTALLATION See Notes 1 and 3

DETAIL B

1/2"

125 lbs

STANDARD UNIT

BASE LEVELING PAD NOTES:

THE LEVELING PAD IS TO BE CONSTRUCTED OF CLASS II AB PER PROJECT SPECIFICATIONS

2. THE BASE FOUNDATION IS TO BE APPROVED BY THE SITE GEOTECHNICAL

ENGINEER PRIOR TO PLACEMENT OF THE


LEVELING PAD

LEVELING PAD.

EXCAVATION LIMITS

9



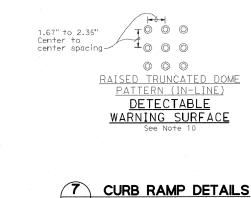




Approximately 3/4"

The fraction of the fraction o

GROOVING DETAIL

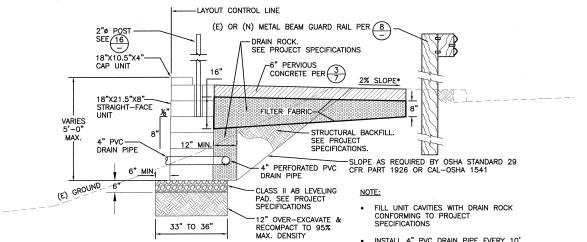

* MATCH EXISTING CROSS SLOPES AT DRIVEWAYS AND CROSS STREETS. TRANSITION CROSS SLOPE 20' ON APPROACH TO STREETS AND DRIVEWAYS. INSTALL 4" PVC DRAIN PIPE EVERY 10'
ALONG FACE OF WALL. INSTALL WALL
DRAINAGE SYSTEM SO THAT PVC PIPE OUTLET DAYLIGHT ON DOWNSLOPE.

-UNIT FACE *DIMENSIONS & WEIGHT MAY VARY BY REGION STANDARD UNIT/BASE PAD ISOMETRIC SECTION VIEW N.T.S.


CAP UNIT


18" 10 1/2"


WIDTH: *DEPTH:

HEIGHT: *WEIGHT:

10 TYPICAL MODULAR CONCRETE WALL SECTION

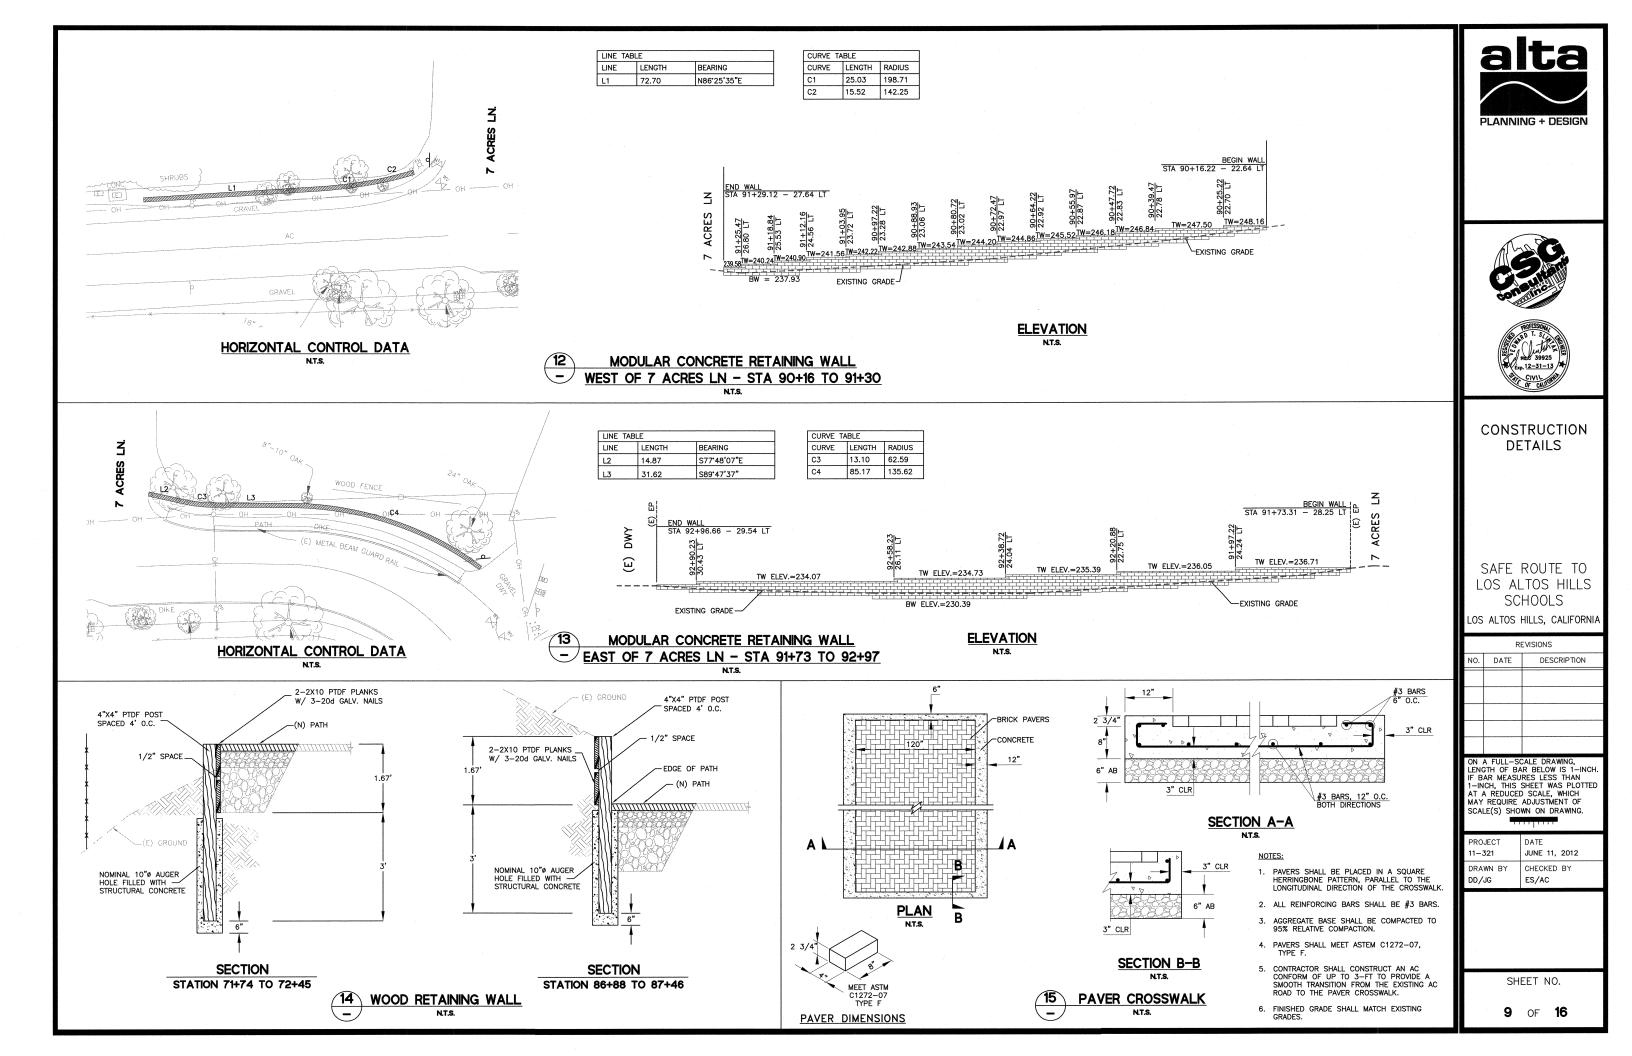

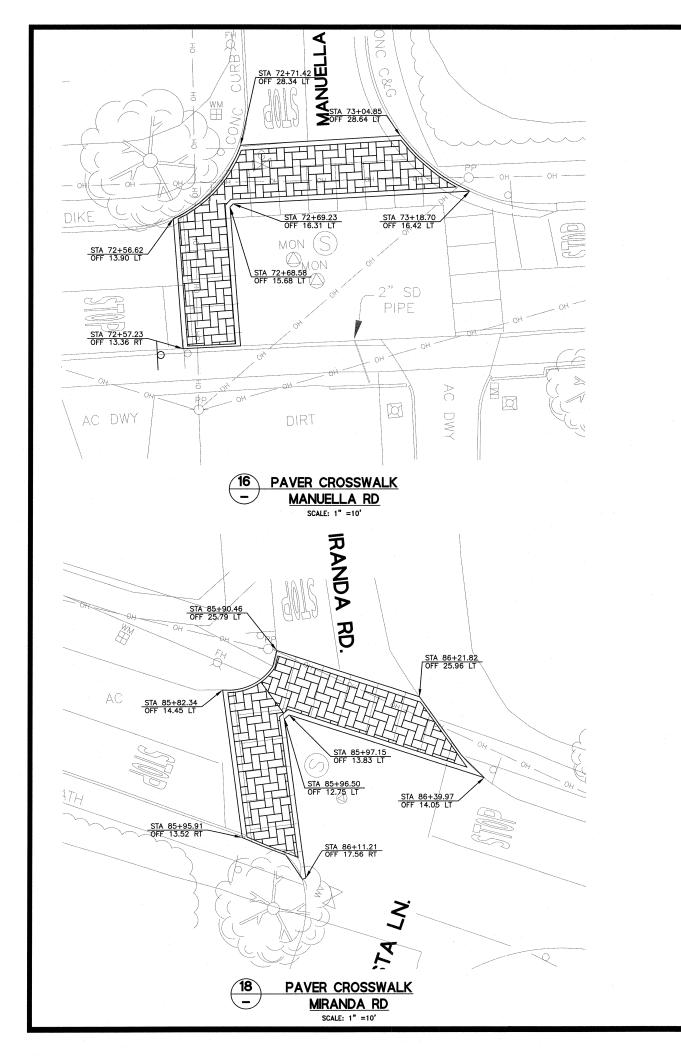

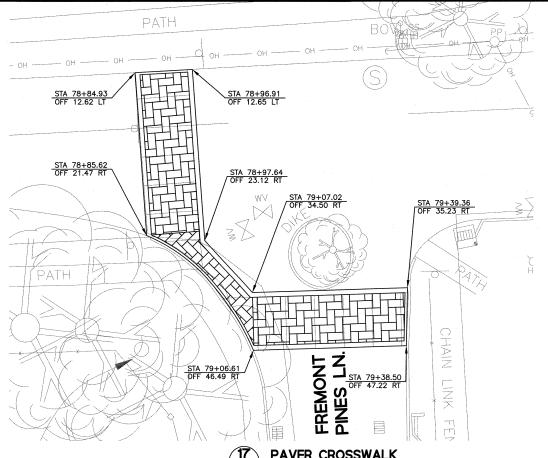

PAVER CROSSWALK
FREMONT PINES LANE
SCALE: 1" =10'







CONSTRUCTION DETAILS

SAFE ROUTE TO LOS ALTOS HILLS SCHOOLS


LOS ALTOS HILLS, CALIFORNIA


	REVISIONS			
NO. DATE DESCRIPTION				


ON A FULL—SCALE DRAWING, LENGTH OF BAR BELOW IS 1—INCH. IF BAR MEASURES LESS THAN 1—INCH, THIS SHEET WAS PLOTTED AT A REDUCED SCALE, WHICH MAY REQUIRE ADJUSTMENT OF SCALE(S) SHOWN ON DRAWING.

ı	PROJECT	DATE
1	11-321	JUNE 11, 2012
	DRAWN BY	CHECKED BY
1	DD/JG	ES/AC

SHEET NO.

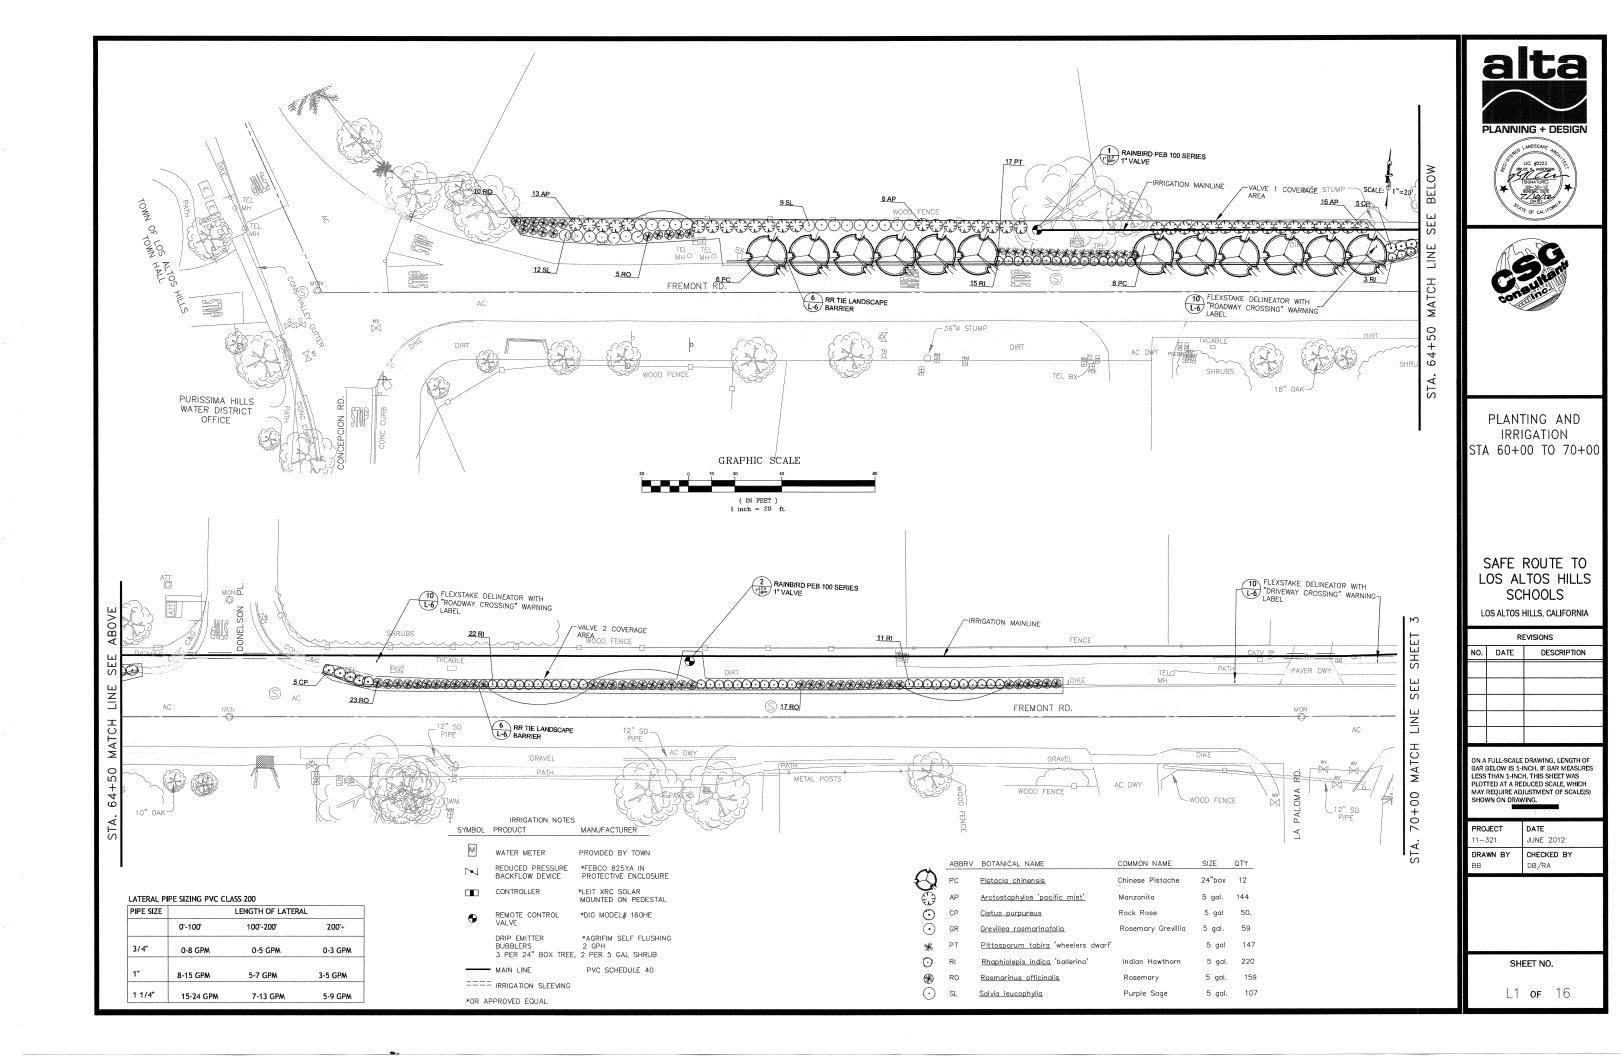

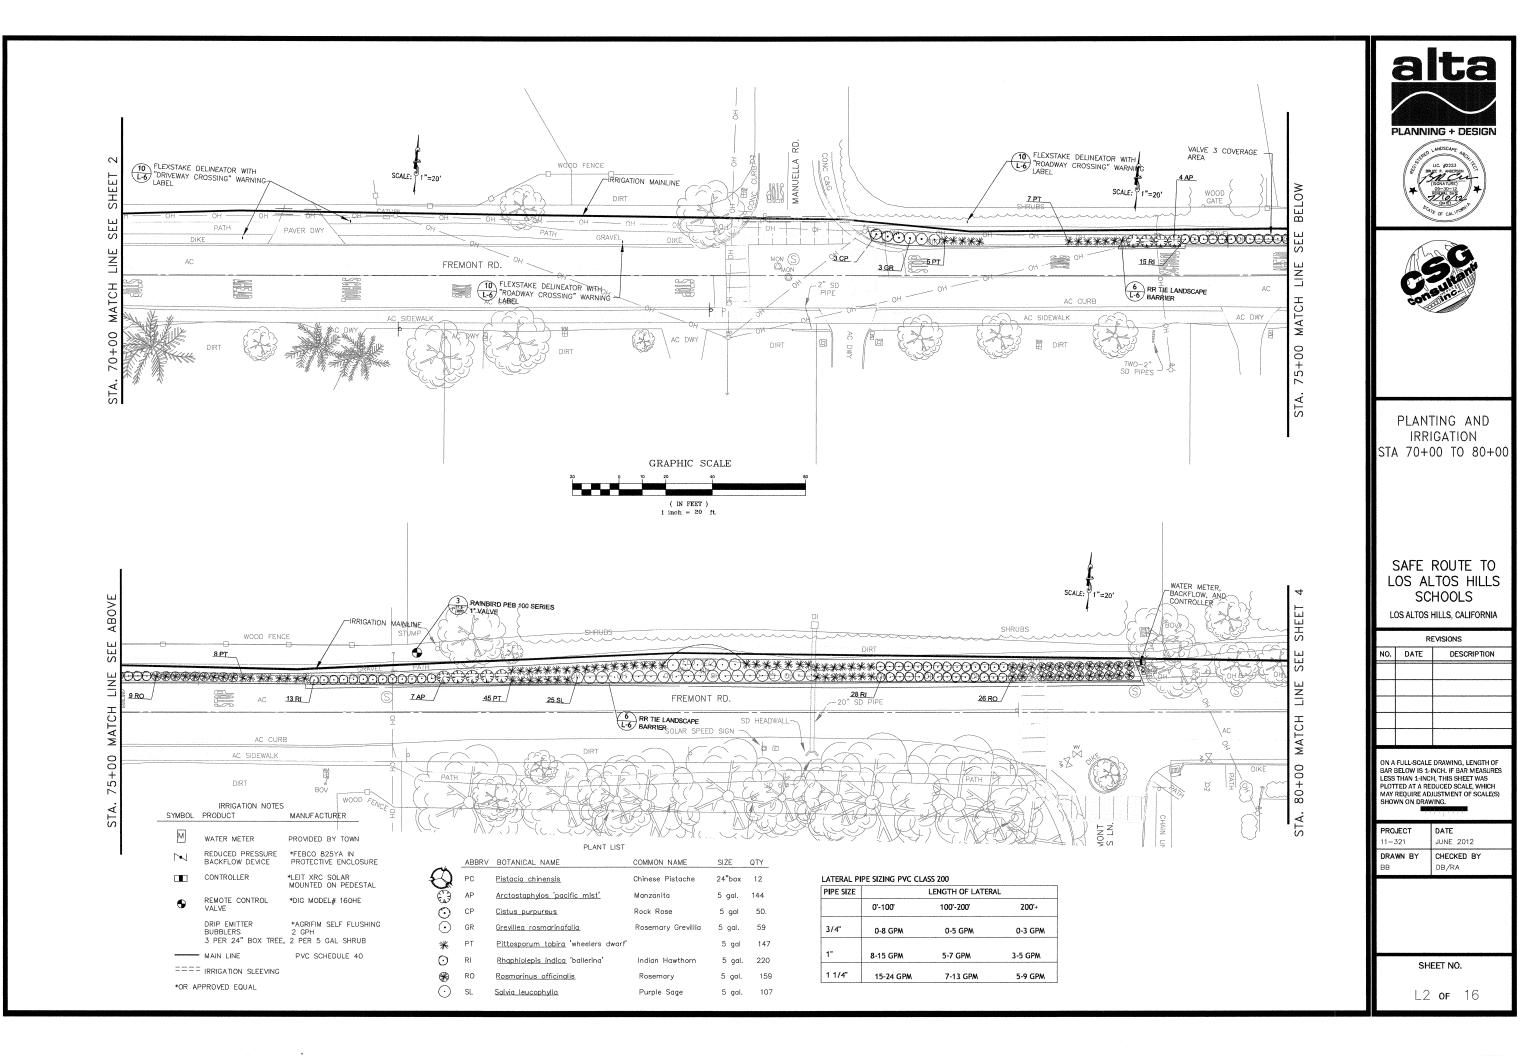

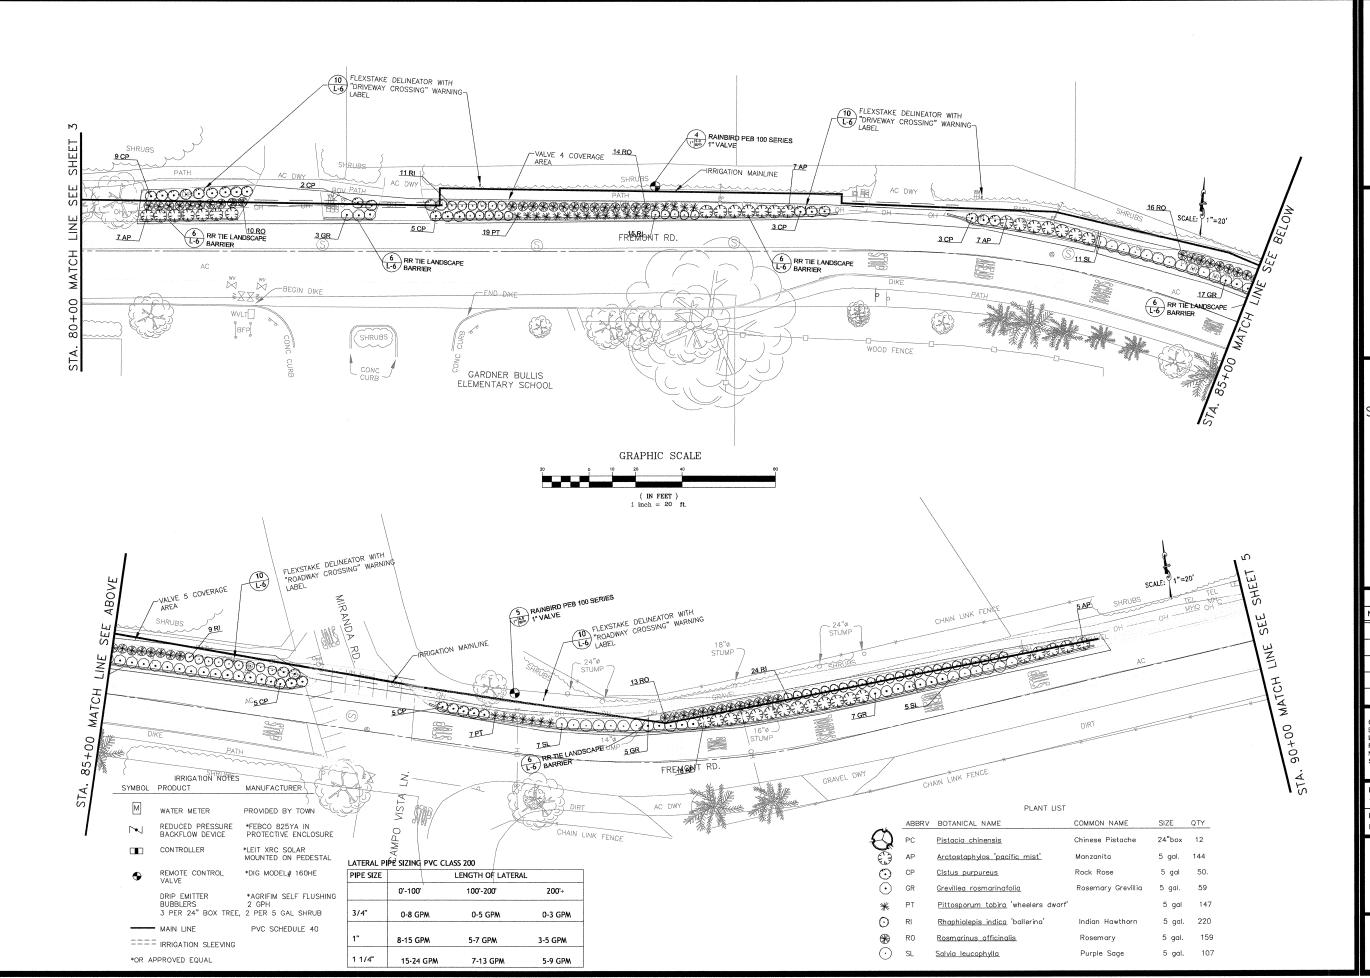





PLANTING AND IRRIGATION PLAN STA 80+00 TO 90+00

SAFE ROUTE TO LOS ALTOS HILLS SCHOOLS

LOS ALTOS HILLS, CALIFORNIA


I		REVISIONS				
I	NO.	DATE	DESCRIPTION			
I						
I						
I						
ı						
I						

ON A FULL-SCALE DRAWING, LENGTH OF BAR BELOW IS 1-INCH. IF BAR MEASURES LESS THAN 1-INCH, THIS SHEET WAS PLOTTED AT A REDUCED SCALE, WHICH MAY REQUIRE ADJUSTMENT OF SCALE(S) SHOWN ON DRAWING.

JUNE 2012
CHECKED BY
DB/RA

SHEET NO.

L3 **of** 16

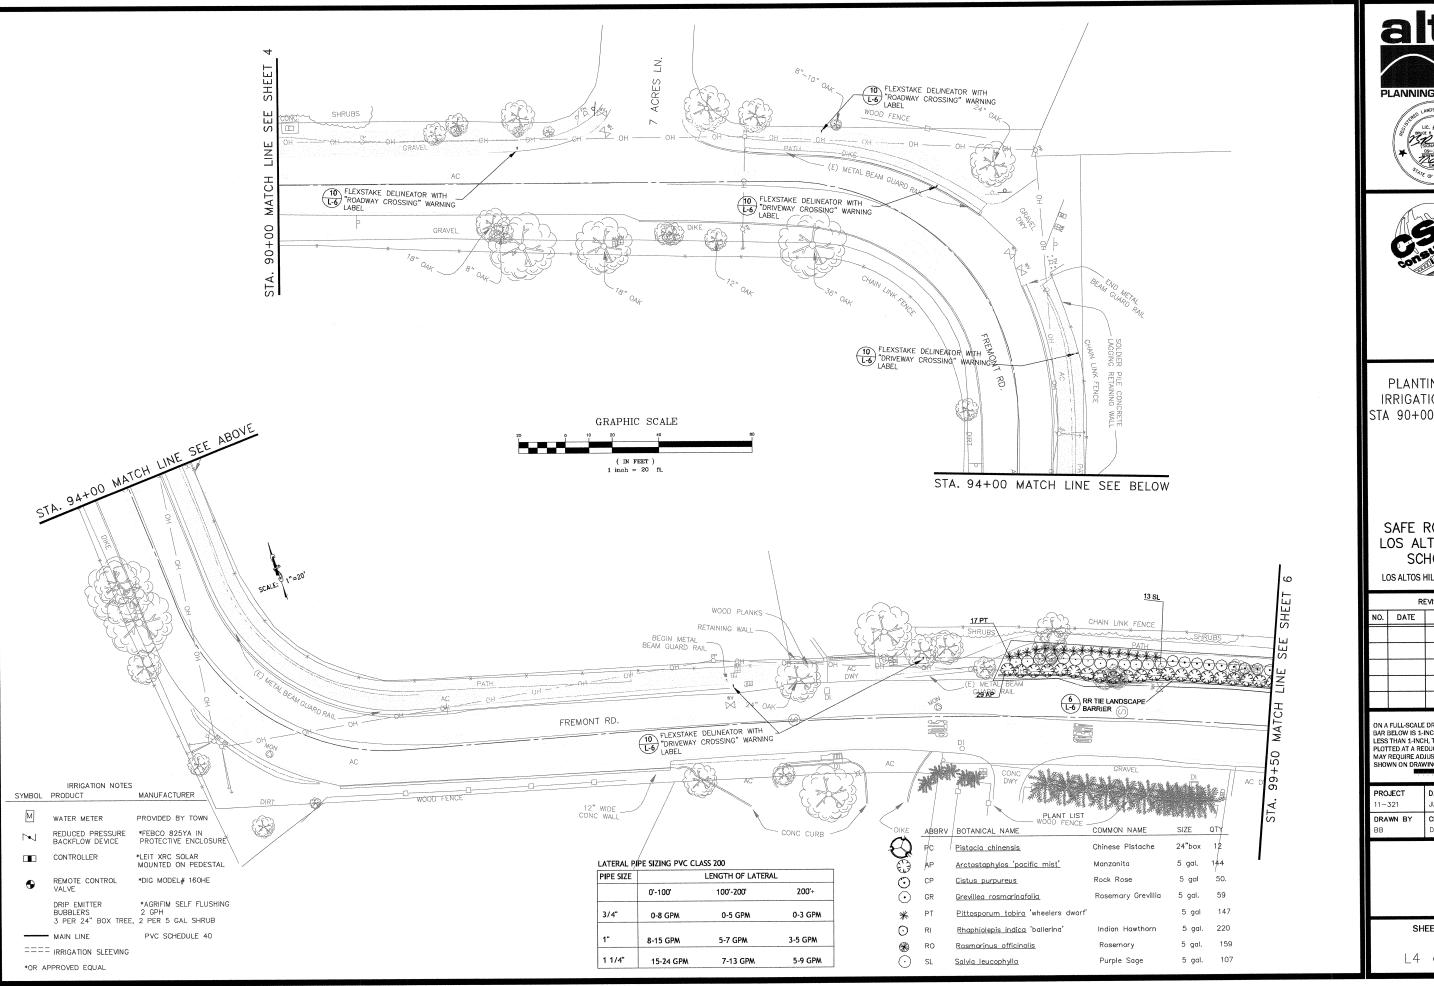





PLANTING AND IRRIGATION PLAN STA 90+00 TO 99+50

SAFE ROUTE TO LOS ALTOS HILLS SCHOOLS

LOS ALTOS HILLS, CALIFORNIA


ŀ	,				
	REVISIONS				
l	NO.	DATE	DESCRIPTION		
ı					
ı					

ON A FULL-SCALE DRAWING, LENGTH OF BAR BELOW IS 1-INCH. IF BAR MEASURES LESS THAN 1-INCH, THIS SHEET WAS PLOTTED AT A REDUCED SCALE, WHICH MAY REQUIRE ADJUSTMENT OF SCALE(S) SHOWN ON DRAWING.

DRAWN BY CHECKED B BB DB/RA	2
	BY

SHEET NO.

L4 **o** 16

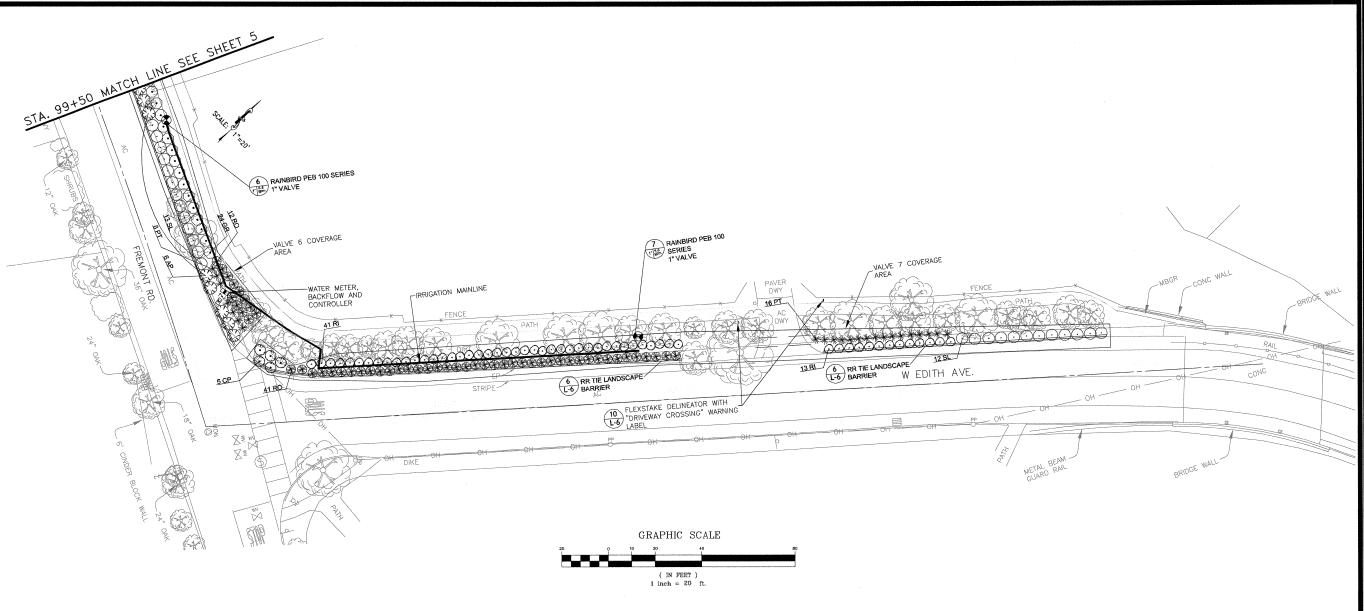

LATERAL PIPE SIZING PVC CLASS 200

PIPE SIZE		LENGTH OF LATERA	NL
	0'-100'	100'-200'	200'+
3/4"	0-8 GPM	0-5 GPM	0-3 GPM
1"	8-15 GPM	5-7 GPM	3-5 GPM
1 1/4"	15-24 GPM	7-13 GPM	5-9 GPM

SYMBOL	IRRIGATION NOTES PRODUCT	MANUFACTURER
М	WATER METER	PROVIDED BY TOWN
\sim	REDUCED PRESSURE BACKFLOW DEVICE	
	CONTROLLER	*LEIT XRC SOLAR MOUNTED ON PEDESTAL
•	REMOTE CONTROL VALVE	*DIG MODEL# 160HE
	DRIP EMITTER BUBBLERS 3 PER 24" BOX TREE,	*AGRIFIM SELF FLUSHING 2 GPH 2 PER 5 GAL SHRUB
***************************************	MAIN LINE	PVC SCHEDULE 40
	IRRIGATION SLEEVING	
*OR AF	PROVED EQUAL	

PLANT LIST

		1 2/11/1 2101			
	ABBRV	BOTANICAL NAME	COMMON NAME	SIZE	QTY
	PC	<u>Pistacia chinensis</u>	Chinese Pistache	24"box	12
£3	AP	Arctostaphylos 'pacific mist'	Manzanita	5 gal.	144
Ō	CP	Cistus purpureus	Rock Rose	5 gal	50.
$\overline{\odot}$	GR	Grevillea rosmarinafolia	Rosemary Grevillia	5 gal.	59
*	PT	Pittosporum tobira 'wheelers dwarf'		5 gal	147
\odot	RI	Rhaphiolepis indica 'ballerina'	Indian Hawthorn	5 gal.	220
₩	RO	Rosmarinus officinalis	Rosemary	5 gal.	159
\odot	SL	Salvia leucophylla	Purple Sage	5 gal.	107





PLANTING AND IRRIGATION PLAN STA 99+50 TO 105+50

SAFE ROUTE TO LOS ALTOS HILLS SCHOOLS

LOS ALTOS HILLS, CALIFORNIA


Ш					
I	REVISIONS				
I	NO.	DATE	DESCRIPTION		
I					
H					
I					
H					
I					

ON A FULL-SCALE DRAWING, LENGTH OF BAR BELOW IS 1-INCH. IF BAR MEASURES LESS THAN 1-INCH, THIS SHEET WAS PLOTTED AT A REDUCED SCALE, WHICH MAY REQUIRE ADJUSTMENT OF SCALE(S) SHOWN ON DRAWING.

PROJECT	DATE
11-321	JUNE 2012
DRAWN BY	CHECKED BY
BB	DB/RA

SHEET NO.

L5 **of** 16

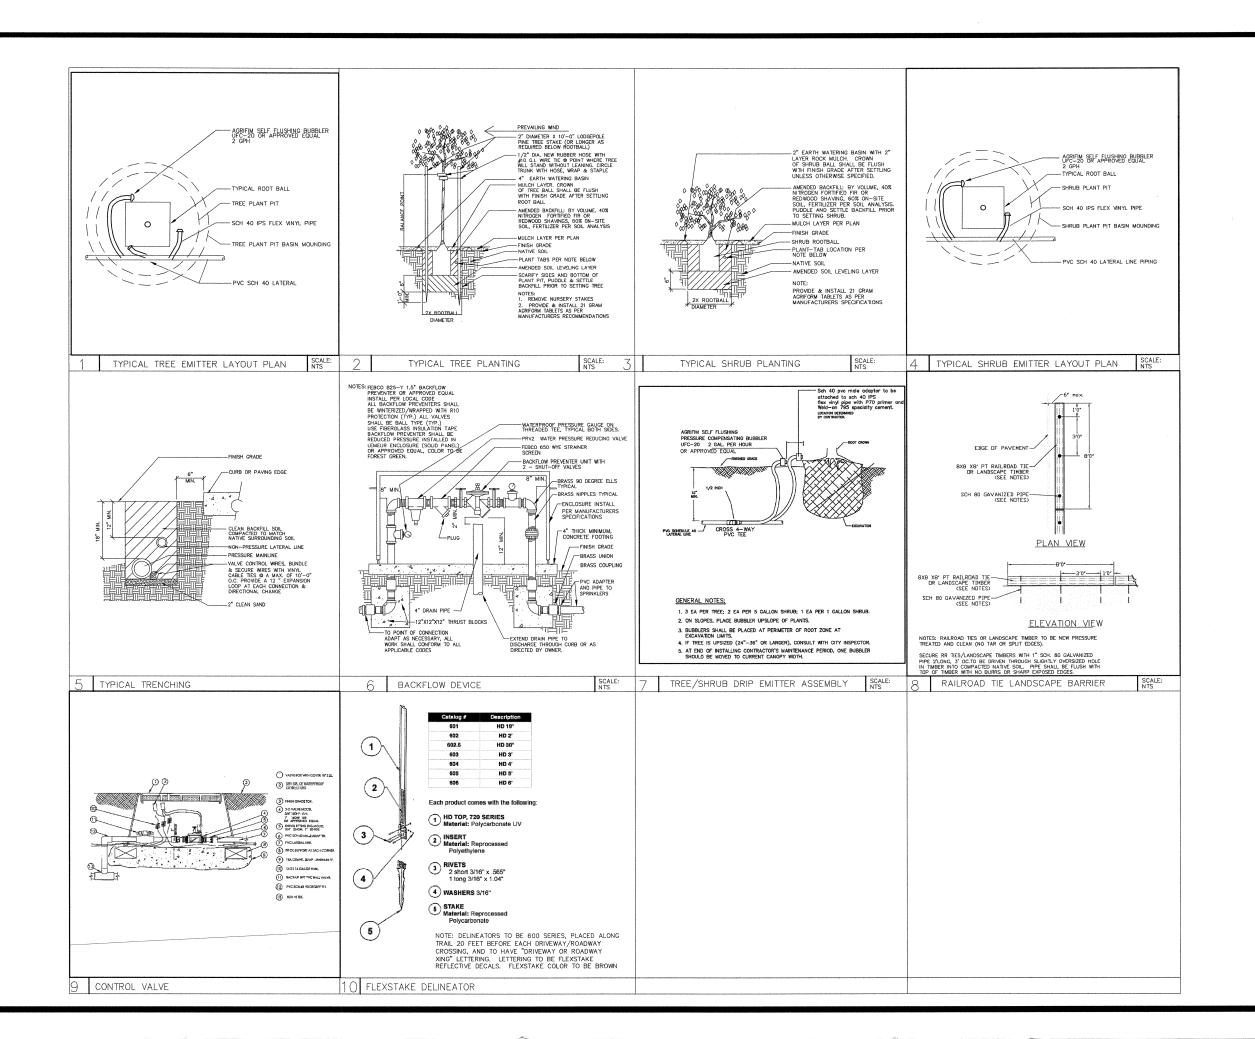





PLANTING AND IRRIGATION DETAILS

SAFE ROUTE TO LOS ALTOS HILLS SCHOOLS

LOS ALTOS HILLS, CALIFORNIA

	REVISIONS		
NO.	DATE	DESCRIPTION	

ON A FULL-SCALE DRAWING, LENGTH OF BAR BELOW IS 1-INCH. IF BAR MEASURES LESS THAN 1-INCH, THIS SHEET WAS PLOTTED AT A REDUCED SCALE, WHICH MAY REQUIRE ADJUSTMENT OF SCALE(S) SHOWN ON DRAWING.

PROJECT	DATE
11-321	JUNE 2012
DRAWN BY	CHECKED BY
BB	DB/RA

SHEET NO.

L6 **of** 16